

Dawson Creek PO box 810 Dawson Creek, BC V1G 4H8 Fort St John 9505 100th Street Fort St John, BC V1J 4N4

P:(250)784-3200 E:prrd.dc@prrd.bc.ca P:(250)785-8084 E:prrd.fsj@prrd.bc.ca

For Office Use:
Receipt #
Date Received
File No
Sign Issued: Yes No N/A

Application for Development

TYPE OF APPLICATION	FΕ	E
☐ Official Community Plan Bylaw Amendment*	\$ 1	,500.00
☐ Zoning Bylaw Amendment* #	\$ 1	,000.00
☐ Official Community Plan / Zoning Bylaw Amendment combined* #	\$ 2	,000.00
☐ Temporary Use Permit*#	\$	750.00
☐ Temporary Use Permit Renewal	\$	350.00
✓ Development Permit #	\$	250.00
☐ Development Permit Amendment #	\$	200.00
☐ Development Variance Permit	\$	500.00
☐ Liquor Licence Referral Application	\$	150.00
* Sign is required for this application type.		
# Contaminated Site Declaration Form required for this application type.		
☐ Exclusion from the Agricultural Land Reserve	\$ 1	,500.00
(Applicant responsible for additional costs associated with the		
advertisements, signage, and facility rental, if applicable)		

2. PLEASE PRINT

Property Owner's Name ANGELA TELFORD	Authorized Agent of Owner (if applicable)
Address of Owner 10112 105TH AVE	Address of Agent
City/Town/Village: FORT ST JOHN	City/Town/Village:
Postal Code: V1J4S4	Postal Code:
Telephone Number:	Telephone Number:
E-mail:	E-mail:

	Notice of	collection	of personal	information
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Personal information on this form is collected for the purpose of processing this application. The personal information is collected under the authority of the *Local Government Act* and the bylaws of the PRRD. Documentation/Information submitted in support of this application can be made available for public inspection pursuant to the *Freedom of Information and Protection of Privacy Act*.

3. PROPERTY DESCRIPTION

Please list the full Legal Description and PID of each property under application		
Legal Description	PID	Area of Each Lot
12264 242 Road, Grandhaven	011-394-943	1.06acres ha./acres
		ha./acres
		ha./acres
		TOTAL AREA 1.06acres ha./acres

			1.06acres ha./acr
4.	CIVIC ADDRESS OR LOCATION OF PROPERTY: 1226	4 242 Road, PeaceRive	r,BC,V1J8A8
5.	PARTICULARS OF PROPOSED AMENDMENT Please check the box(es) that apply to your application	on type:	
	[] Official Community Plan (OCP) Bylaw amendment		
	[] Zoning Bylaw amendment: Proposed Land Use:		
	[] Development Variance Permit – describe propose	ed variance request:	
	[] Temporary Use Permit or Temporary Use Permit	Renewal – describe proposed	use:
	[✓] Development Permit or Development Permit Ame	endment	
	[] Liquor Licence Referral Application		
6.	Describe the existing uses and buildings on the subject	• • •	half of building

/. 3	We would like to add a portable classroom on site so students can have a traditional classroom setting
	Describe the landscaping being proposed on the property: No additional landscaping will be required
9. F	Reasons and comments in support of the application. Attach a separate sheet if necessary: This portable will be used for indigenous education studies for GrK-12 use, at various times
	Describe the proposed and/or existing means of sewage disposal for the property: There is a septic field supplied after two inground settling tanks.
	Describe the proposed and/or existing means of water supply for the property: We rely on hauled water that fills a cistern under the building

THE FOLLOWING INFORMATION IS REQUIRED FOR ALL APPLICATIONS:

- 14. Proof of ownership of the subject property or properties dated no more than thirty (30) days prior to the date of application. (For example: State of Title Certificate, BC Land Title Office Property Title Search, Corporate Registry Search, or recent Property Tax Notice.)
- 15. A Sketch Plan of the subject property or properties, showing the following:
 - (a) the legal boundaries and dimensions of the subject property;
 - (b) boundaries, dimensions, and area of any proposed lots (if subdivision is being proposed);
 - (c) the location and size of existing buildings and structures on the subject property, with distances to property lines;
 - (d) the location and size of any proposed buildings, structures, or additions thereto, with distances to property lines;
 - (e) the location of any existing sewage disposal systems;
 - (f) the location of any existing or proposed water source;
 - (g) the location and dimensions of all accesses and egresses to the property including driveways;
 - (h) any existing landscaping or vegetation;
 - (i) any existing landscaping or vegetation to be removed; and
 - (j) any new landscaping or vegetation proposed.

		11/13/2025	
Signature of Owner	5 h	Date signed	
ignature of Owner		Date signed	
AGENT'S AUTHORIZATION If you have an agent act on your behalf in submission of this application, the following			
f you have an agent act on your be		this application, the following	
f you have an agent act on your be outhorization <u>MUST</u> be signed by <u>A</u>			
	LL property owners. and	this application, the following hereby authorize of landowner)	
f you have an agent act on your be outhorization MUST be signed by <u>A</u>	LL property owners. and	hereby authorize	



Contaminated Site Declaration Form

I, <u>Angela Telfed</u> , hereby acknowledge that the <i>Environmental Man</i> 2003, as amended, is effective as of February 1, 2021.	
Legal Description of Subject Land(s):	
*	
believe that it is or has been used for any of specified in Schedule 2 of the regulations	my personal knowledge of the property in question, I do not of the industrial or commercial purposes and activities . Accordingly, I elect not to complete and submit a <i>Site</i> on 40 (1) of the <i>Environmental Management Act</i> .
	ore of the identified purposes or activities is or has occurred on contact staff to submit a Site Disclosure Statement at
I further acknowledge that this declaration applicable under the legislation.	n does not remove any liability, which may otherwise be 11 / 11 /2025 dd mm yy
Owner/Agent	

For more information, please visit the Ministry's Identification of Contaminated Sites webpage or email siteID@gov.bc.ca

	INDUSTRIAL DEVELOPMENT PERMIT AREA GUIDELINES CHECKLIST		
	Guidelines	Comments	
	Building Sitin	g and Design	
1.	Where industrial buildings or structures are sited on parcels adjacent to controlled access highways they shall be located towards the front parcel line, with parking and loading areas located to the side or rear of the parcel.	Our building will be placed between the main road and existing building, with parking to the side, as you desire. We are be compliant with this in our plan	
2.	Accessory buildings and uses including storage, repair, and maintenance areas shall be located at the rear or side of the parcel, away from the highway and road right-of-way, in order to enhance the appearance of the development along any such highway or road right-of-way.	We have no accessory buildings in this plan, so this is not applicable to our application.	
3.	Building entrances shall be oriented towards the front parcel line and be clearly identifiable. Architectural features such as canopies, lighting and building articulation which highlight entrances are encouraged.	We have decided to have the front entrance to the classroom building in the same direction as the existing building, towards the parking lot. We didn't want the kids to feel they were walking into the street.	
4.	Buildings and parking areas shall incorporate universal design principals.	We have an accessible ramp for universal design.	
5.	Buildings, accesses and parking areas should be designed in a manner that is easy to understand and navigate while ensuring pedestrian safety.	We will be encouraging students and visitors to park in the current lot under the site lighting and not next to the unmarked are by the classroom so it does not become disorganized, and/or unsafe	

Agreed, we do not have the building in this 6. No buildings or structures shall be located location and will not be changing it from its within the sight triangle, as shown in Figure 8 current appearance, we are open to feedback. Sight Triangle. ROAD NOT TO SCALE Figure 8 Sight Triangle **Winter Design Considerations** 7. Buildings should be designed to maximize We are adding window on road side, that side has trees we hope to keep up sunlight exposure to absorb and retain heat during winter months while providing shade from the summer sun. 8. Building roofs and eaves should be designed to prevent snow from accumulating and sliding on to the ground below. 9. Snow storage areas should be situated in areas We have a large green space behind the school for the snow storage to go to absorb that receive long periods of sunlight to quickly into the soil melt and drain the snow and generally be out of site from highway and road right-of-ways. 10. Snow storage areas should be located and Same answer as 10. designed to minimize runoff from snow melt Our neighbors are not agricultural though entering naturalized areas or adjacent agricultural lands. **Materials** 11. Exterior building materials shall be durable and We have vinyl-siding, not brick or stucco Ne nave viry siality,
Our siding is corrogated metal
11/24/2025 of high quality. We will have a professional, simple aesthetic 12. Buildings adjacent to controlled access to our building highways are encouraged to include a mixture of exterior building cladding materials, such as brick, stone, wood, or other durable and aesthetically pleasing material.

Parking, Loading	, and Circulation
13. Parking areas should be well-identified from the highway and from major roads.	Our existing parking lot will not change and be visible from the street
Lands	caping
14. All work, including landscaping, planning, design, installation and maintenance shall be executed to the Canadian Landscape Standards or other applicable trade associations.	We are not altering the perimeter landscaping with this portable install we will make sure the building has 360degree clearance around for snow removal
15. Parcels abutting lands zoned Agriculture shall provide a buffer as per the Ministry of Agriculture's Guide to Edge Planning.	We are not abutting agricultural land at current, so this n/a
16. Landscaping should be used to protect the building from direct sunlight during afternoon hours during the summer and permit sunlight penetration in the winter.	Agreed, we want to leave the trees along the road
17. Landscaping should be designed to shield buildings from strong winds and to not block solar access for south facing walls and windows.	Agreed, we want to leave the trees along the road
18. Landscaping designs should maximize the retention of existing vegetation or the use of new plantings such as native vegetation, rough grasses and hardy and drought-tolerant plant species.	We lose grass under the portable and under paving.
19. Parking areas shall be screened from adjacent highway or road right-of-ways by placing on private property trees at a ratio of 3:1 coniferous to deciduous, at least 6 cm in diameter at breast height at the time of planting and spaced at maximum 10 m intervals.	We have no plans to change the current parking lot, we hope that is satisfactory
20. Landscaping shall be designed so that no plantings occur within the required sight triangle, as shown in Figure 8 Sight Triangle.	Agreed, we will not plant in this triangle

Screening a	nd Buffering
21. Off-street parking, loading, and storage areas shall be separated from adjacent residential or agricultural designated parcels, by a landscape buffer at least 6 m in width.	This will not apply, not loading or storage areas
22. Parcels abutting natural areas or lands designated as residential or park, open space, natural environment, shall provide a landscape buffer.	Our neighbors are zoned for industrial use as well, even though there are residences on them today, so this does not apply
23. Whenever possible, retain existing vegetation to serve as a landscape buffer between adjacent properties. In situations where this is not possible, existing vegetation may be removed and a new landscape screen may be planted in accordance with General Development Permit Area Policy 9 and other policies of this section.	Agreed, I do not want to down any trees and this location was picked so we could keep trees
24. Buildings and structures fronting Highway No. 97 and Highway No. 29 shall be separated from the highway by a landscape buffer. Such areas may be broken only for driveways.	We are on 242 Rd, not the highway, so this should not apply
25. Industrial uses abutting residential or agricultural uses should provide opaque fencing, such as wood fencing, at the property line with a minimum height of 1.8 m.	Our neighbors are zoned for industrial use as well, even though there are residences on them today, so this does not apply
26. Industrial uses abutting other industrial uses or commercial uses may utilize chain link fencing with a minimum height of 1.8 m.	We have chain link around our property

27. Alternative buffers may be considered,
including earth berms that block the line of
sight between industrial and residential,
agricultural, or natural areas, consisting of soil,
seeded to grass in the same year the berm is
built, with optimal vegetative growth such as
shrubs planted along the top of the berm. Such
berms should be a heigh of approximately 3 m
above adjacent grades and have a base of
approximately 9 m.

Lighting

- 28. Light pollution and over-spill illumination into adjacent properties should be minimized. Where lighting occurs in parking areas, it should be designed without glare to the adjoining land parcels or public right-of-way.
- We have high site lighting in existing parking lot, this portable classroom will no change the parking lot lighting or site lighting
- 29. All parking lots, loading bays and other semiprivate spaces should be well lit during the nighttime and winter months.

Agreed, pre-existing lighting on site is available for people during dark times


Environmental Protection

30. If proposed development or works may potentially affect natural features, slopes, water, or riparian areas, or environmentally sensitive areas such as fish habitat or wildlife habitats, the applicant may be required to submit, at the applicant's expense, further documentation, technical studies, plans, and recommendations with respect to the effects of the proposed development or works including any of the following:

This portable location does not affect natural features, slopes, water, or riparian areas, or environmentally sensitive areas such as fish habitat or wildlife habitats.

- a) An environmental assessment report prepared by a registered professional biologist
- b) An erosion and sediment control plan
- c) A vegetation management plan

31. A vegetative buffer separation is encouraged between development and natural, undeveloped areas.	We have a lot of green space on this site
32. Whenever possible, natural vegetation should be maintained.	Agreed, we have a loarge natural open green space on our site
33. Development should be sited in order to protect natural watercourses, riparian corridors and floodplains from erosion, channel migration and flooding.	Our portable and buildings are sited to protect and minimize damage to nature
34. Protect natural flora and fauna habitat, including nesting, denning, and breeding sites.	Agreed, we are not downing any trees

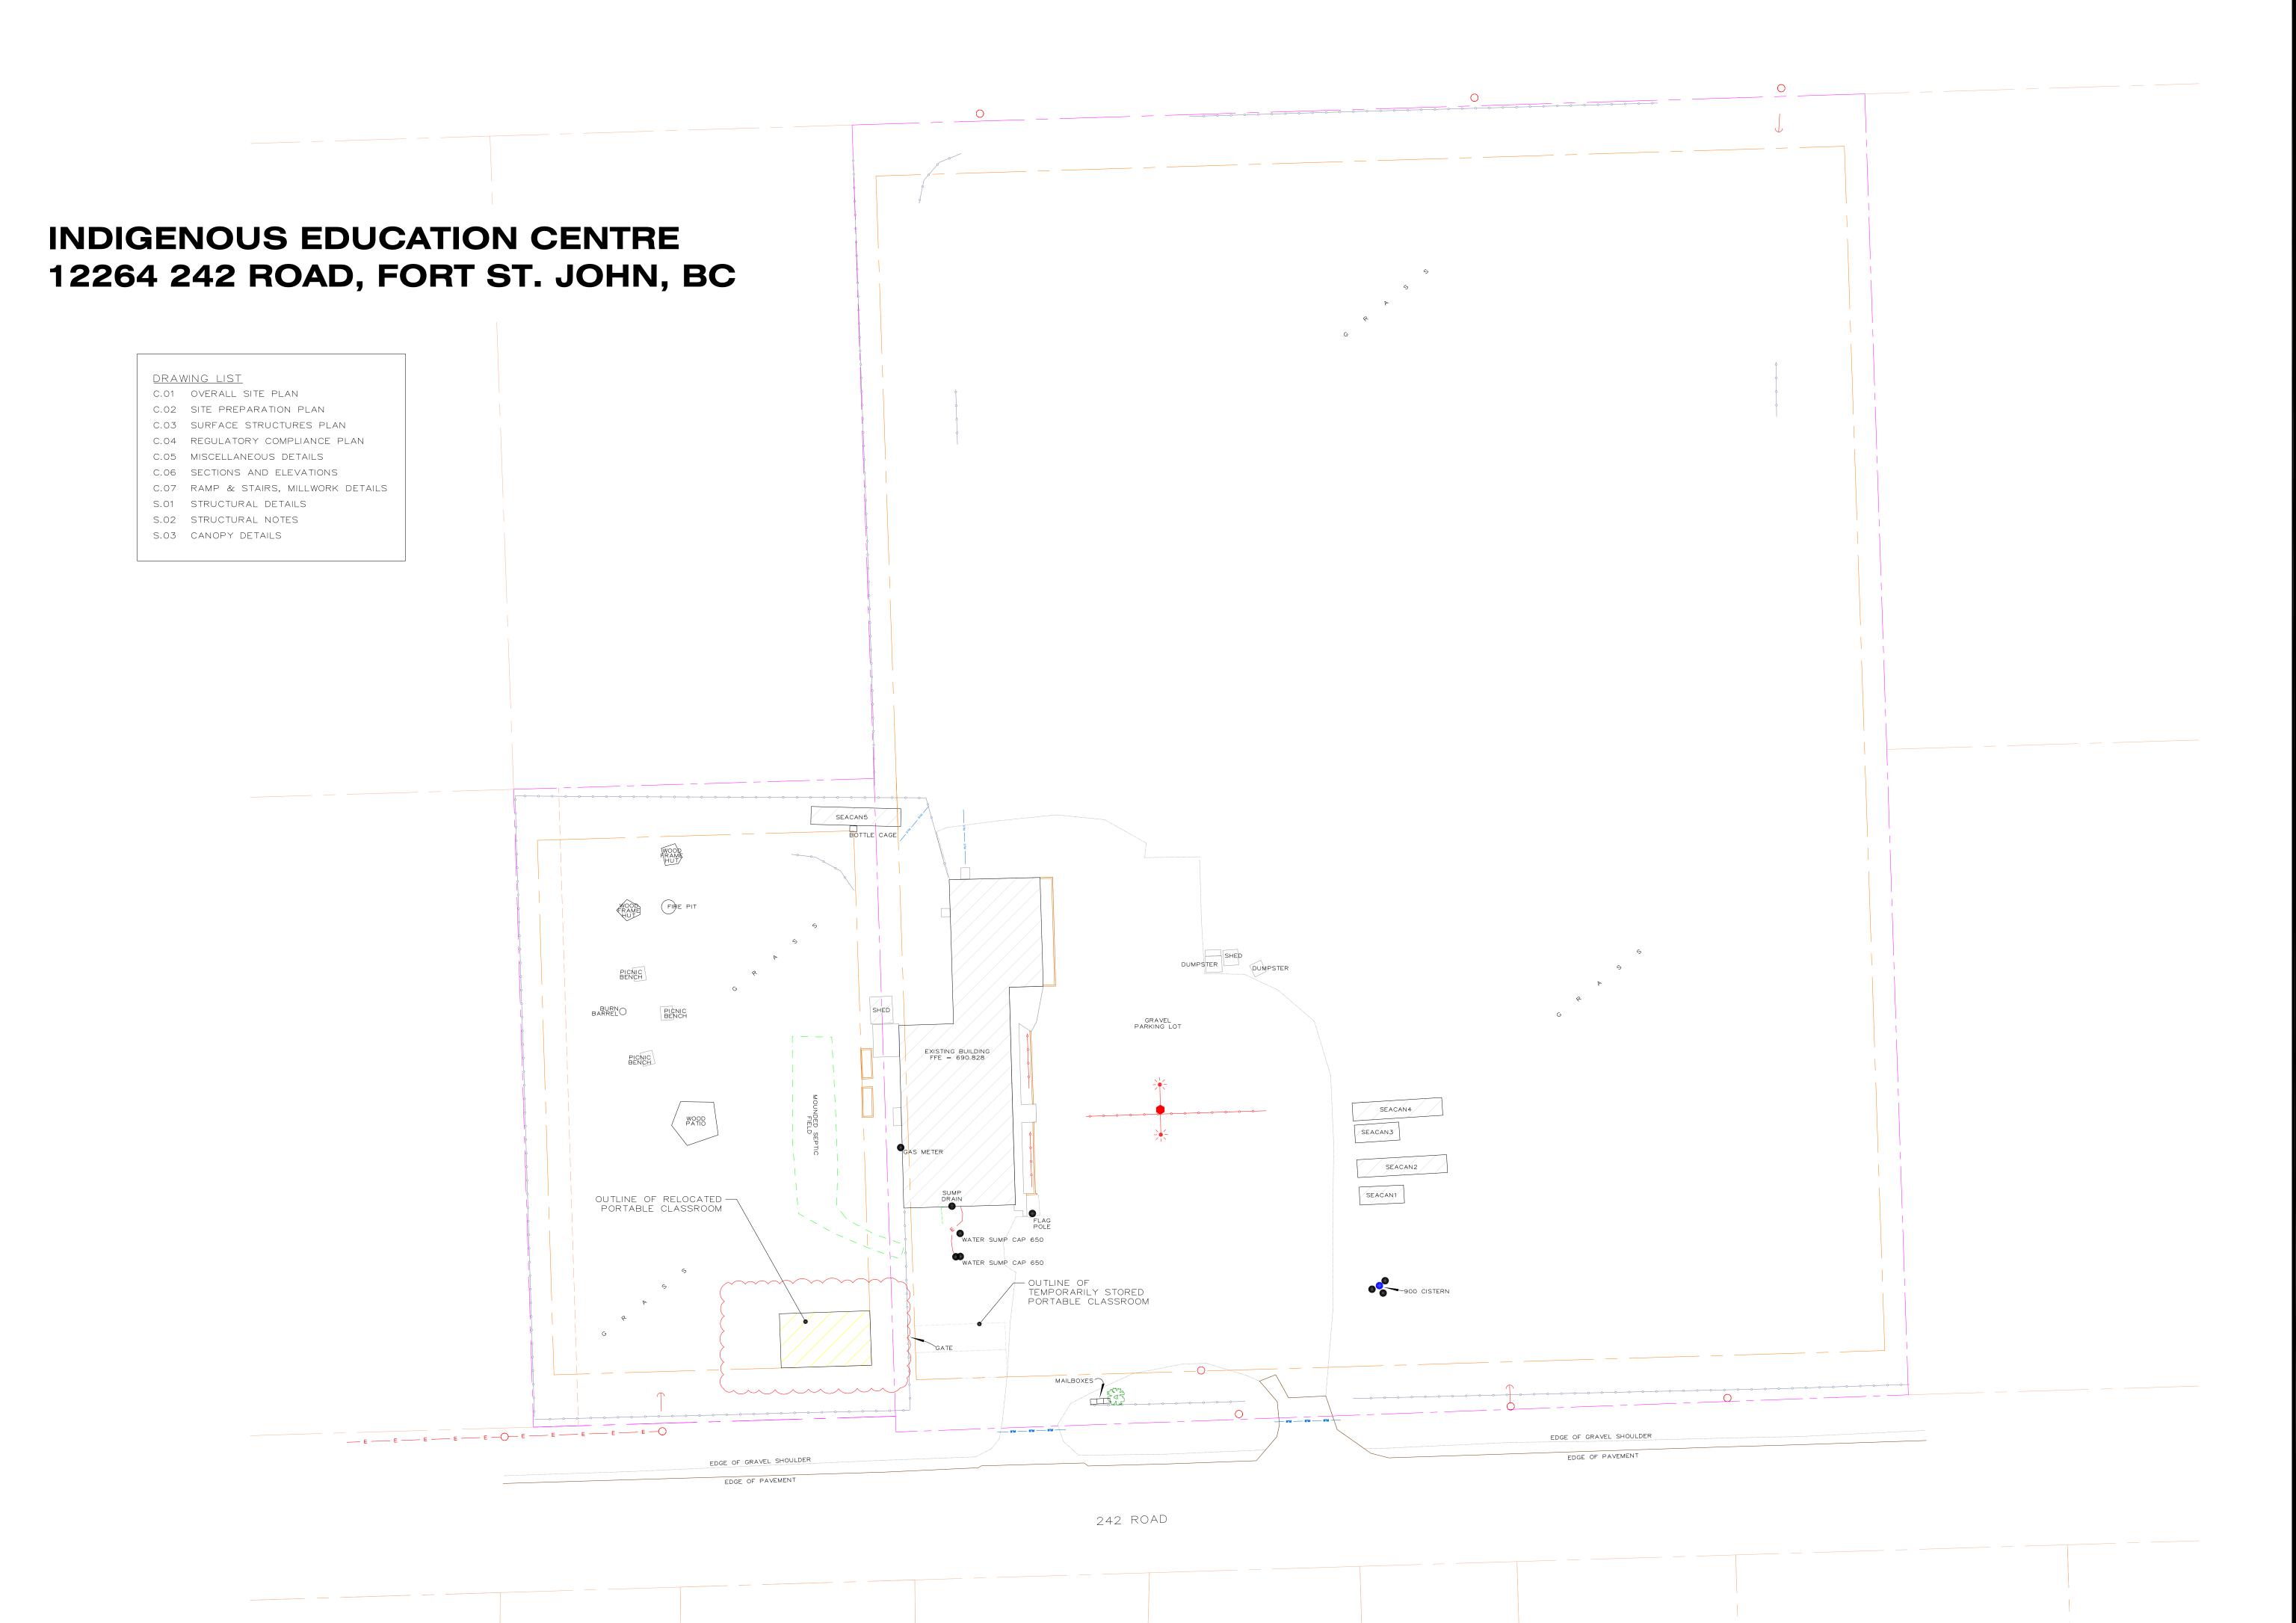



NO. DATE REVISION DRA 1 09.10.25 MISC. REVISIONS FJG	AWN
1 09.10.25 MISC. REVISIONS FJG	;






SCHOOL DISTRICT 60
PEACE RIVER NORTH


Board Office 10112 105 Avenue Fort St. John, BC V1J 4S4 Tel. 250-262-6000

INDIGENOUS EDUCATION CENTRE PORTABLE CLASSROOM

OVERALL SITE PLAN

Project No.	Drawing No.
25-IEC-PRT	
Scale NTS	$+ \cap \cap 1$
Scale 1412] \(\cdot \c
Date 03.10.2025	

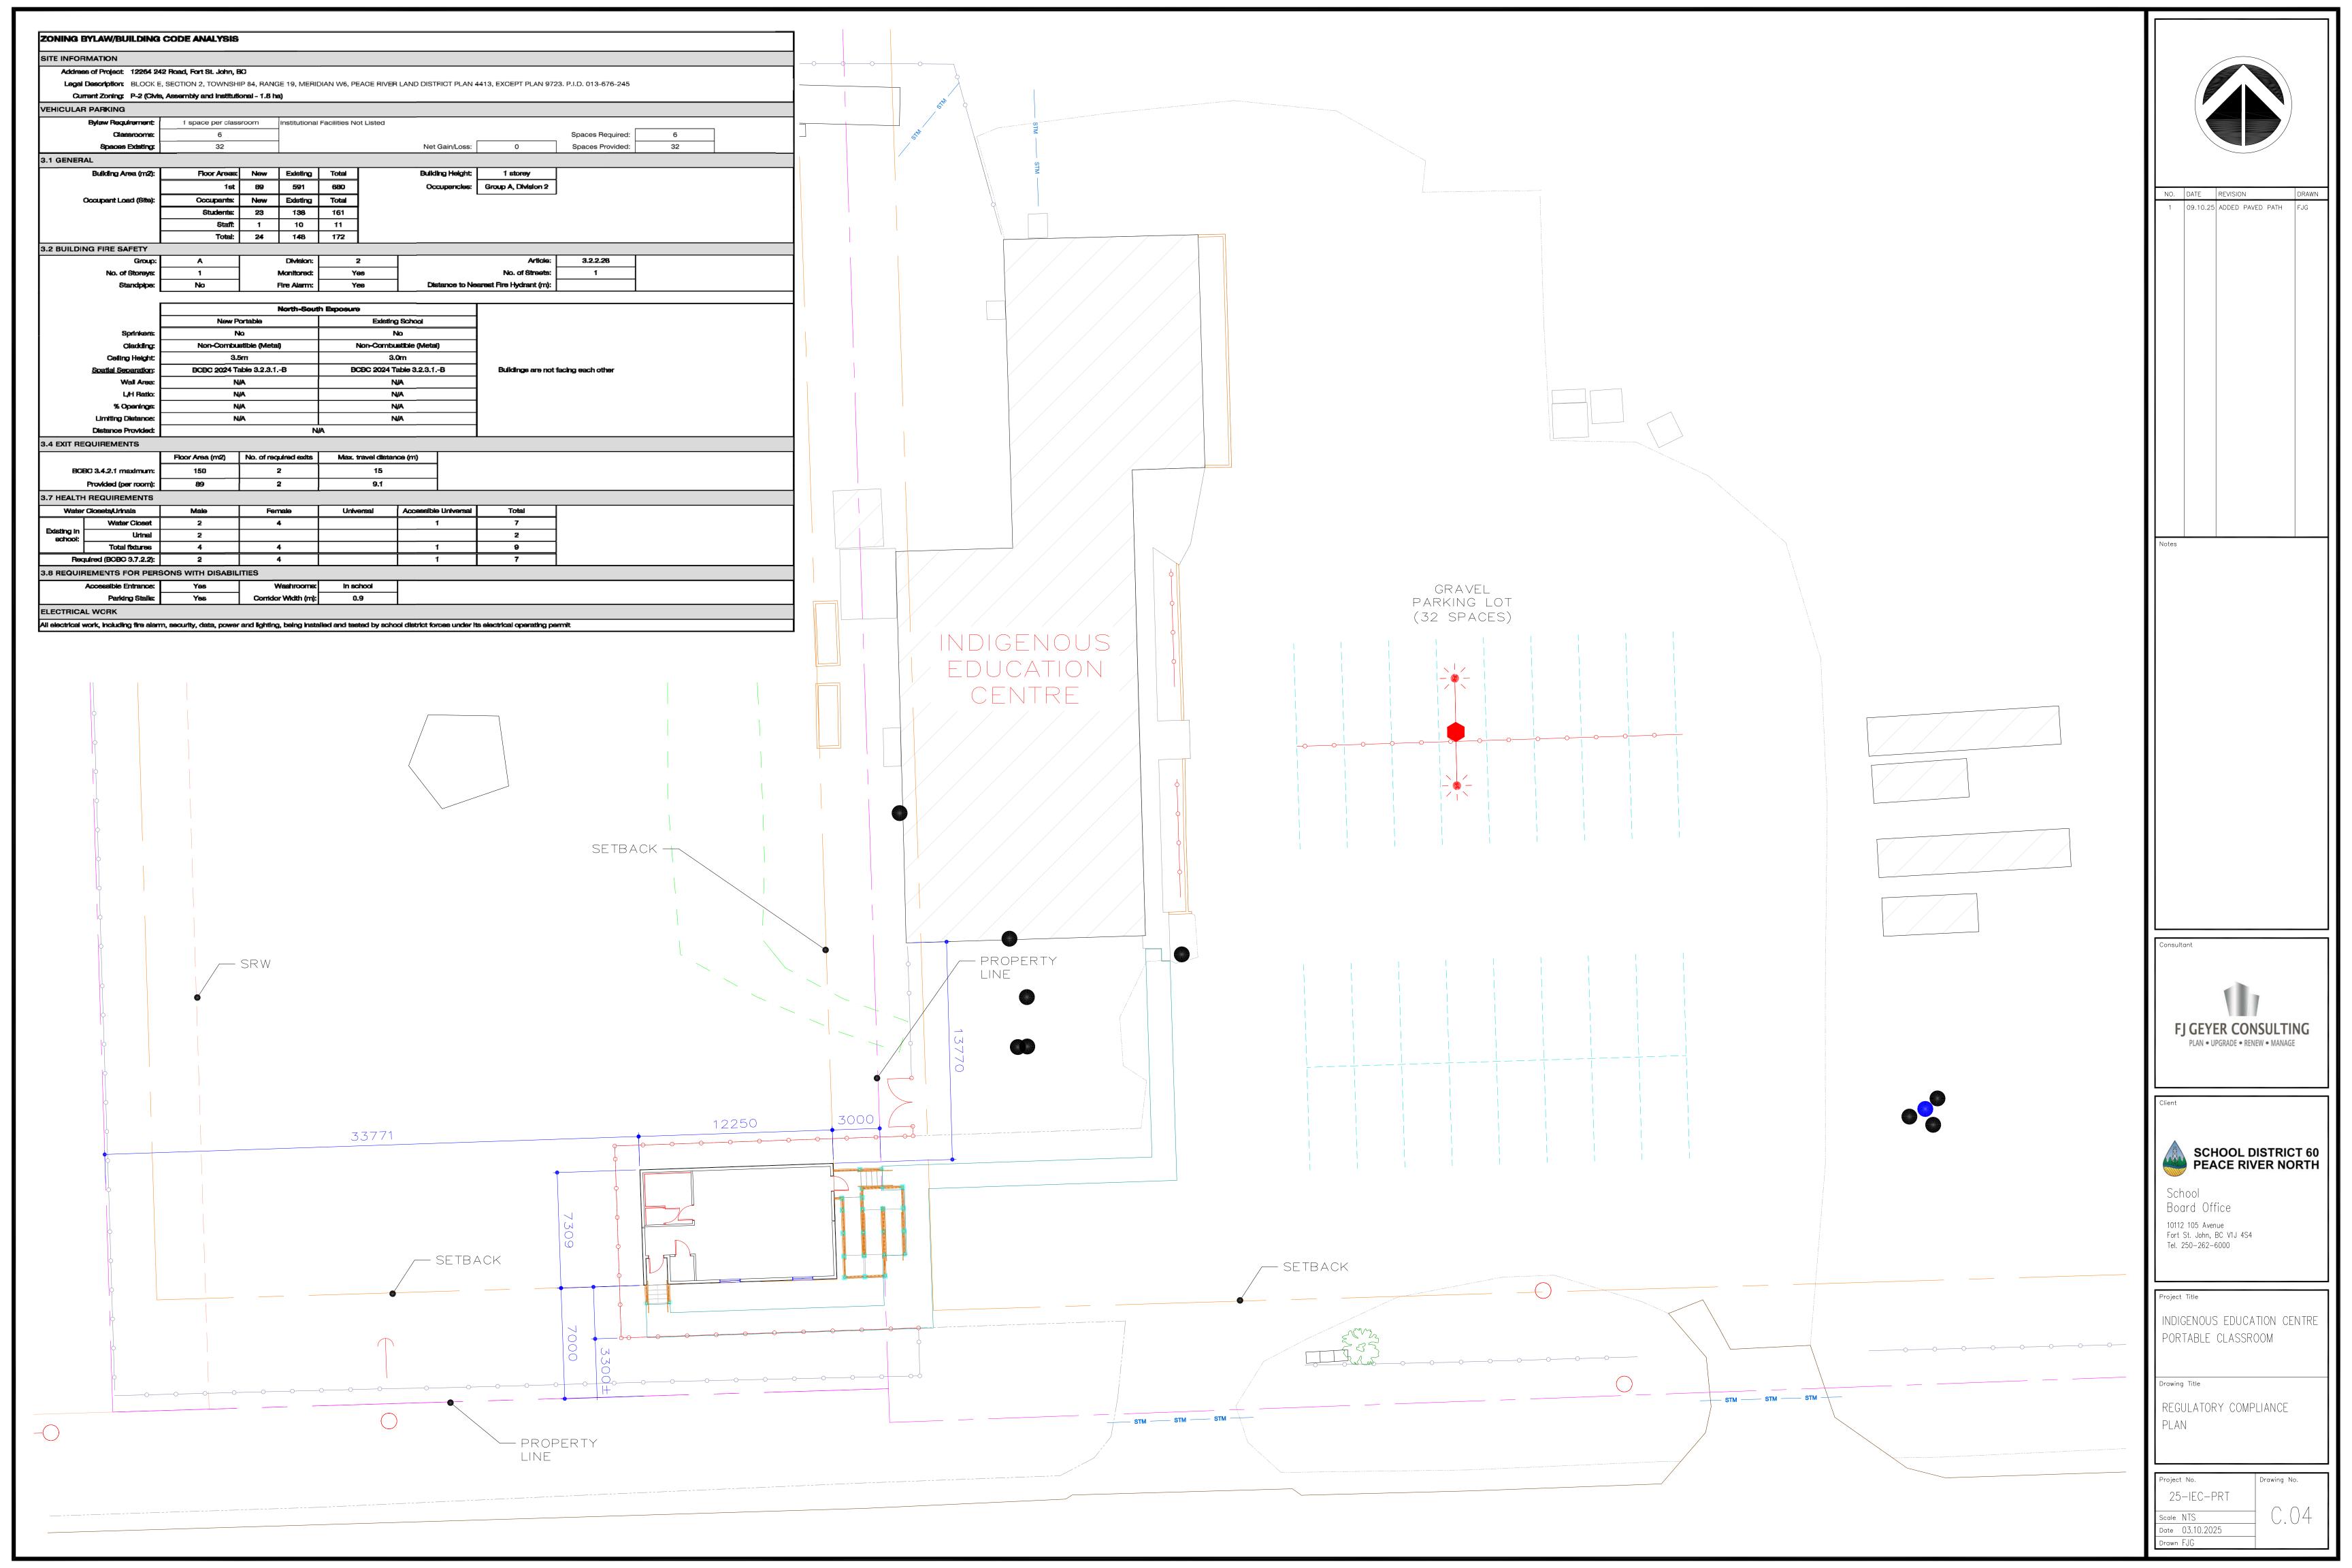

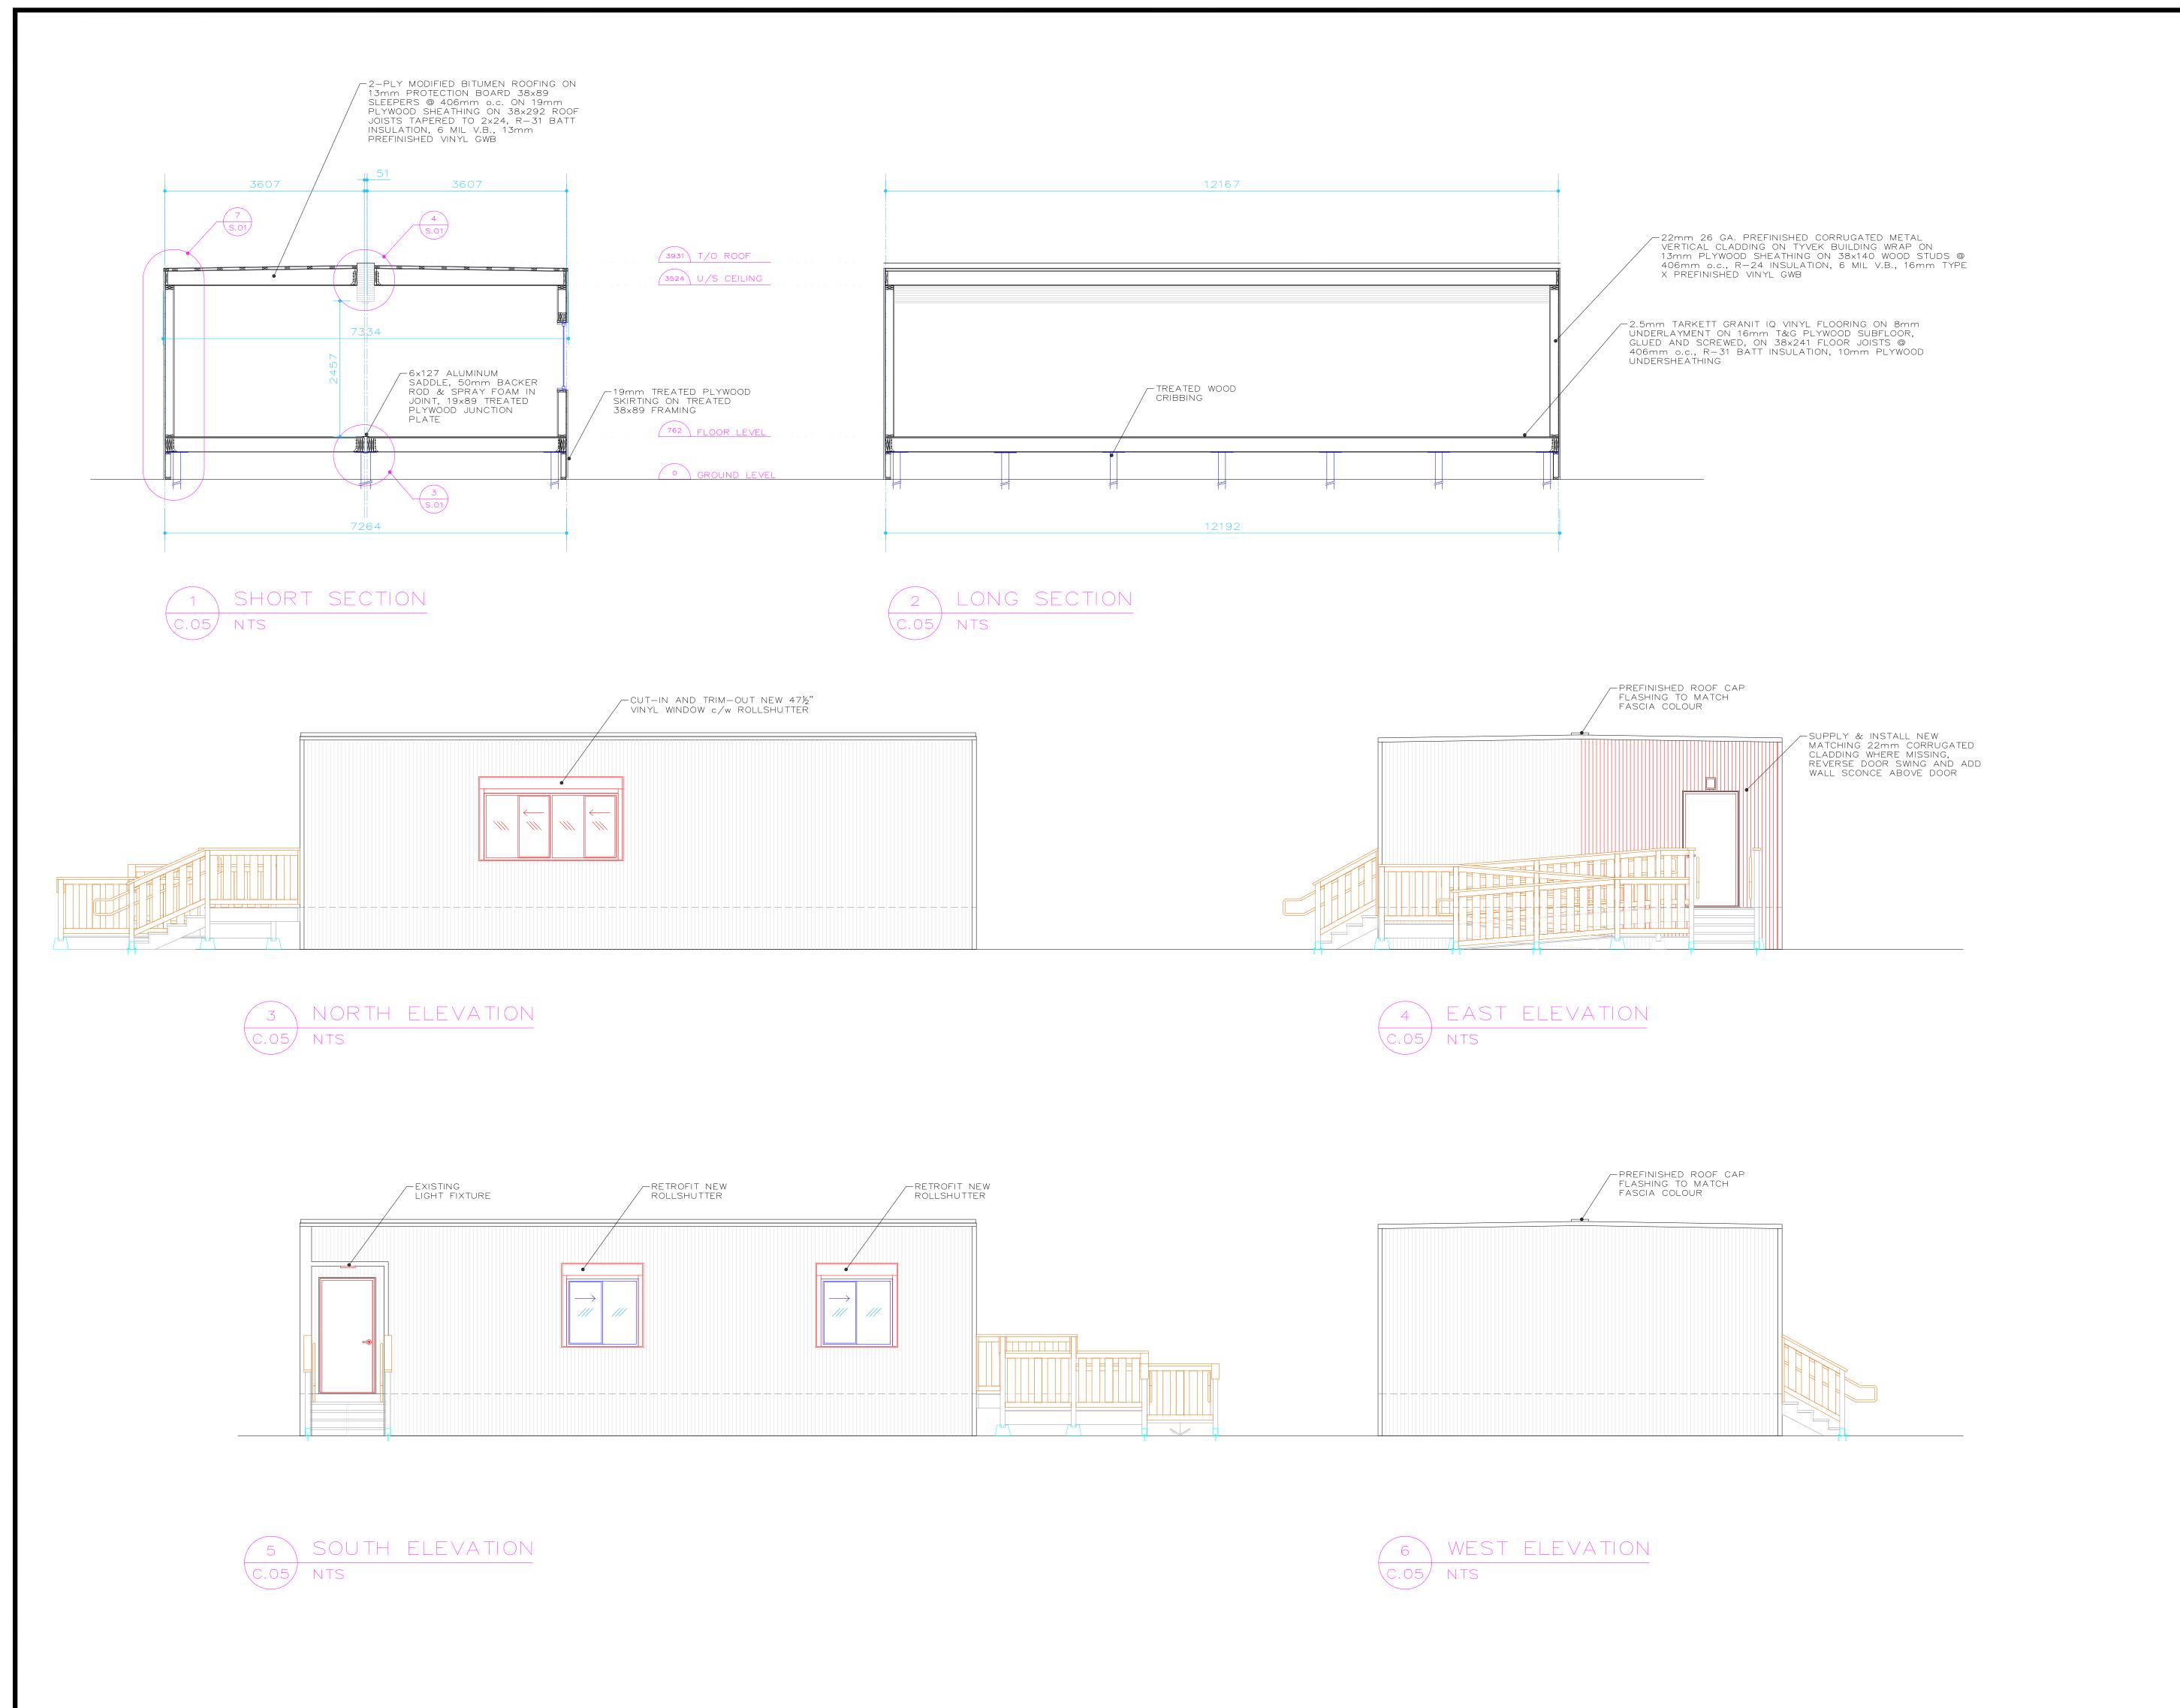

NO. DATE REVISION

Consultant







School Board Office 10112 105 Avenue Fort St. John, BC V1J 4S4 Tel. 250-262-6000

Project Title

INDIGENOUS EDUCATION CENTRE
PORTABLE CLASSROOM

Drawing Title

SECTIONS
AND ELEVATIONS

Project No.	Drawing No.
25-IEC-PRT	
Scale NTS	1 (),()6
Date 03.10.2025	
Drawn FJG	